
MSU PAISLEY COURT HOUSING


101 PAISLEY COURT BOZEMAN, MT, 59715

ISSUE DATE: 03/29/2024

MSU PPA NUMBER: 21-0143 A&E PROJECT NUMBER: 21-0143

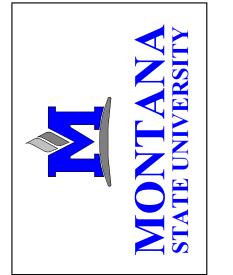



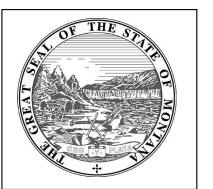


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BOZEMAN, MONTANA
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ASU PAISLEY COURTHOUSING



DRAWN BY: **Author**REVIEWED BY**Checker**REV. DESCRIPTION DATE

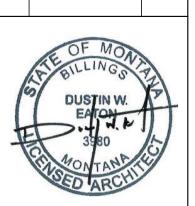

PPA #: 21-0

A/E # 21-0143

A&E PROJ #:

SHEET TITLE COVER SHEET

SHEET

G0.0

ARCHITECTURAL ABBREVIATIONS

		- /\D	DILLIATION		
AB	ANCHOR BOLT	GA	GAUGE	R	RADIUS
ABV	ABOVE	GALV	GALVANIZED	RA	RETURN AIR
A/C	AIR CONDITIONING	GB	GYPSUM BOARD	RB	RUBBER BASE
ACT	ACOUSTICAL CEILING TILE	GC	GENERAL CONTRACTOR	RD	ROOF DRAIN
ADDL	ADDITIONAL	GL	GLASS, GLAZING	RECY	RECYCLE(D)
ADJ	ADJUSTABLE	GWB	GYPSUM WALL BOARD	REF	REFERENCE
AFF	ABOVE FINISH FLOOR	GYP	GYPSUM		REFRIGERATOR OR
ALT	ALTERNATE	•			REFRIGERATION
ALUM	ALUMINUM	HC	HANDICAP	REINF	REINFORCE
ARCH	ARCHITECT(URAL)	HDR	HEADER	REQD	REQUIRED
AWN	AWNING	HDW	HARDWARE	RM	ROOM
		HM	HOLLOW METAL	RO	ROUGH OPENING
B/	BOTTOM OF	HORIZ	HORIZONTAL	ROW	RIGHT OF WAY
BD	BOARD	HR	HOUR		
BLDG	BUILDING	HT	HEIGHT	S	SOUTH
BLKG	BLOCKING BEAM OR BENCHMARK	HTD	HEATED HEATING/VENTILATION & AIR	SC SCH	SOLID CORE
BM BRG	BEAM OR BENCHMARK	HVAC	CONDITIONING		SCHEDULE SCHEDULED
BTWN	BEARING BETWEEN		CONDITIONING	SECT	SECTION
BUR	BUILT-UP ROOF	ID	INSIDE DIAMETER	SF	SQUARE FEET
DOIX	BOILT-OF ROOF	INFO	INFORMATION	SFRM	SPRAY APPLIED FIRE RESISTIVE
CAB	CABINET	ISO	ISOCYANURATE	OFFICE	MATERIAL
CJ	CONTROL JOINT	INSUL	INSULATE / INSULATED / INSULATION	SGL	SINGLE
CL	CENTERLINE	INT	INTERIOR	SHT	SHEET
CLG	CEILING	INV	INVERT	SHTG	SHEATHING
CMU	CONCRETE MASONRY UNIT			SIM	SIMILAR
CO	CLEAN OUT	JT	JOINT	SPECS	
COL	COLUMN	J-BOX	JUNCTION BOX	SOD	SLAB ON DECK
CONC	CONCRETE			SOG	SLAB ON GRADE
CONT	CONTINUOUS	KIT	KITCHEN	SOH	SAME OPPOSITE HAND
CONST				SS	STAINLESS STEEL
CG	CORNER GUARD	L	LONG / LENGTH	ST	STONE TILE
CPT	CARPET	LAM	LAMINATE(D)	STD	STANDARD
CSMT	CASEMENT	LAV	LAVATORY	STND	STANDARD
CT	CERAMIC TILE	LF	LINEAR FEET	STL	STEEL
D	DEEP	LT	LIGHT	STRUCT	STRUCTURAL
DF	DRINKING FOUNTAIN	MAS	MASONRY	TEMP	TEMPERED
DH	DOUBLE HUNG	MATL	MATERIAL	THK	THICK
DIM(S)	DIMENSIONS	MAX	MAXIMUM		THRESHOLD
DISP	DISPENSER	MECH	MECHANIC(AL)	T.O.	TOP OF
DN	DOWN	MEZZ	MEZZANINE	TOBM	TOP OF BEAM
DR	DOOR	MFR	MANUFACTURER		TOP OF BEAM
DS	DOWNSPOUT	MH	MANHOLE		TOP OF PLATE
DTL	DETAIL	MIN	MINIMUM	T.O.S.	TOP OF STEEL
DWG	DRAWING	MISC	MISCELLANEOUS	T/	TOP OF
		MO	MASONRY OPENING	T&G	TONGUE AND GROOVE
Е	EAST	MTL	METAL	TEL	TELEPHONE
EA	EACH			THK	THICK
EC	EXISTING COLUMN	N	NORTH		TRANSOM
EJ	EXPANSION JOINT	NIC	NOT IN CONTRACT	TV	TELEVISION
ELEC	ELECTRICAL	NOM	NOMINAL	TYP	TYPICAL
EL ELEV	ELEVATION ELEVATOR	NTS	NOT TO SCALE	UL	UNDERWRITERS LABORATORY
EQ	EQUAL	ОС	ON CENTER	UNO	UNLESS NOTED OTHERWISE
EQUIP	EQUIPMENT	OD	OUTSIDE DIAMETER OR OVERFLOW	UNO	UNLESS NOTED OTHERWISE
EWC	ELECTRIC WATER COOLER	OB	DRAIN	VB	VINYL BASE
EXH	EXHAUST	OPNG	OPENING	VCT	VINYL COMPOSITION TILE
EXIST	EXISTING	OPP	OPPOSITE	VERT	VERTICAL
EXP	EXPANSION OR EXPOSED	OSB	ORIENTED STRAND BOARD	VEST	VESTIBULE
EXT	EXTERIOR	OVHD	OVERHEAD	VIF	VERIFY IN FIELD
				VP	VENEER PLASTER
FACP	FIRE ALARM CONTROL PANEL		PLATE	VR	VAPOR RETARDER
FD	FLOOR DRAIN	PLAM	PLASTIC LAMINATE	VT	VINYL TILE
FE	FIRE EXTINGUISHER		PLUMBING	VWC	VINYL WALL COVERING
FEC	FIRE EXTINGUISHER CABINET		PLYWOOD		
F.F.	FINISH FLOOR	PNL	PANEL	W	WIDE OR WEST
FIN	FINISH	PNT	PAINT	W/	WITH
FIXT	FIXTURE	POLY	POLYESTER OR POLYOLEFIN	WC	WATER CLOSET
FLR	FLOOR FOUNDATION	PSF	POUNDS PER SQUARE FOOT	WDW	WINDOW
FND FP	FOUNDATION FIRE PROTECTION	PSI PT	POUNDS PER SQUARE INCH PRESSURE TREATED OR POINT	WDW WG	WINDOW WALL GUARD
FP FR	FRAME	PT PVMT	PAVEMENT	WG WH	WALL GUARD WATER HEATER
FRMG	FRAMING	1 V (V) I	I / VV CIVICIA I	W/IN	WITHIN
FT	FEET/FOOT OR FIRE TREATED	QT	QUARRY TILE	W/IN	WITHOUT
FTG	FOOTING	QTR	QUARTER	WP	WATERPROOF
FTNG	FOOTING	QTY	QUANTITY	WR	WATER RESISTANT
FRP	FIBERGLASS REINFORCED			WT	WEIGHT
	PANEL			WWF	WELDED WIRE FABRIC

WWF WELDED WIRE FABRIC

NUMBER OR POUND

PROJECT TEAM

FRT FIRE RETARDANT TREATED

OWNER

MONTANA STATE UNIVERSITY
PO BOX 172760
BOZEMAN, MT 59717

CONTACT: DONNY BEEBE
PROJECT MANAGER
DONALD.BEEBE@MONTANA.EDU


ARCHITECT

A&E ARCHITECTS515 W. ASPEN ST. SUITE 200A
BOZEMAN, MT 59715
406.453.7310

CONTRACTOR

TBD

EXPLANATION OF SYMBOLS

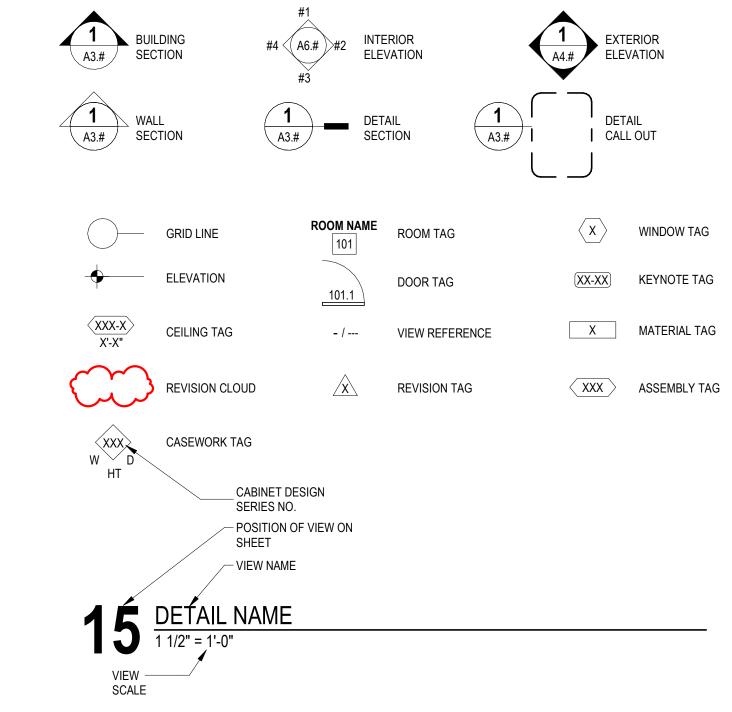

TYPICAL SHEET VIEW NUMBERING LAYOU

	_	_					
1	2	3	4				
5	6	7	8				
9	10	11	12				
13	14	15	16				
ARCH D (24"x36")							

DISCLAIMER:

A&E DESIGN MAKES NO REPRESENTATION AS TO THE COMPLETENESS, APPROPRIATENESS, OR COORDINATION OF INFORMATION PROVIDED BY, AND IS NOT LIABLE FOR, THE WORK OF CONSULTANTS CONTRACTUALLY ENGAGED BY OTHERS.

ALTERNATES

BASE BID: REMOVE EXISTING DRIP EDGE FLASHING AND PROVIDE NEW FLASHING TUCKED UNDER EXISTING ROOFING AND FACE-ATTACHED THROUGH FASCIA PANEL.

ALTERNATE #1: REMOVE 3'-0" OF SHINGLES ALONG ALL ROOF EDGES TO ALLOW FOR INSTALLATION OF NEW DRIP EDGE FLASHING AND NEW UNDERLAYMENT. UNDERLAYMENT TO LAP OVER EXISTING UNDERLAYMENT, CONFIRM EXISTING IN FIELD. PROVIDE NEW SHINGLES TO MATCH EXISTING.

SUSTAINABILITY NOTES

- REPETITIVE AND/OR INTERMITTENT HIGH-LEVEL NOISE PERMITTED ONLY DURING DAYTIME. AT 50'-0" FROM THE PROJECT BOUNDARY DO NOT EXCEED 70 DB(A) FOR MORE THAN 12 MINUTES IN ANY HOUR.
- 2. MAXIMUM AMBIENT NOISE LEVELS (DB) FOR NOISE AREA AT PROJECT BOUNDARY: DAYLIGHT HOURS 65 DB, NON-DAYLIGHT HOURS 45 DB.
- DEVELOP A WASTE MANAGEMENT PLAN ACCORDING TO ASTM E 1609. PLAN SHALL CONSIST OF WASTE IDENTIFICATION, WASTE REDUCTION WORK PLAN, AND COST/REVENUE ANALYSIS. DISTINGUISH BETWEEN CONSTRUCTION WASTES. INDICATE QUANTITIES BY WEIGHT OR VOLUME, BUT USE SAME UNITS OF MEASURE THROUGHOUT WASTE MANAGEMENT PLAN.
- DEVELOP A WASTE REDUCTION WORK PLAN. IDENTIFY NON-HAZARDOUS DEMOLITION AND CONSTRUCTION WASTE GENERATED BY THE PROJECT AND WHETHER IT WILL BE SALVAGED, RECYCLED, OR DISPOSED OF IN LANDFILL. INCLUDE QUANTITY OF EACH TYPE OF WASTE, QUANTITY FOR EACH MEANS OF RECOVERY, AND HANDLING AND TRANSPORTATION PROCEDURES.
- 5. RECYCLED MATERIALS: DIVERT, AT A MINIMUM, 50% OF RESULTING WASTE FROM A LANDFILL THROUGH SALVAGE AND RECYCLING. SEPARATE RECYCLABLE WASTE FROM OTHER WASTE MATERIALS, TRASH, AND DEBRIS.
- DEVELOP A CONSTRUCTION IAQ MANAGEMENT PLAN. AT A MINIMUM, SCHEDULE OF INSTALLATION OF INTERIOR FINISHES, IDENTIFY SOURCES OF ODOR AND DUST, NOTE CONSTRUCTION VENTILATION PROVIDED INCLUDING USE OF PERMANENT HVAC SYSTEMS, TYPES OF FILTRATION AND SCHEDULE FOR REPLACEMENT OF FILTERS, CLEANING AND DUST CONTROL PROCEDURES, PRODUCTS REQUIRING MOISTURE PROTECTION, AND SCHEDULE FOR INSPECTION OF STORED MATERIALS.
- 7. DEVELOP A TEMPORARY SEDIMENTATION CONTROL PLAN. INDICATE DEVICES, MEASURES, AND LOCATIONS FOR SEDIMENT CONTROL DEVICES, DESCRIBE CONSTRUCTION ACTIVITIES EFFECTING EROSION, DESCRIBE MONITORING AND MEASURES FOR SEDIMENT CONTROL, DESCRIBE MITIGATION AND RESPONSE TO FAILED EROSION CONTROL MEASURES.
- 8. LOW EMITTING MATERIALS. PAINTS, COATINGS, ADHESIVES AND SEALANTS FOR FIELD APPLICATIONS INSIDE THE WEATHER PROOFING SYSTEM SHALL COMPLY WITH VOC CONTENT LIMITS OF AUTHORITIES HAVING JURISDICTIONS OR SCAQMD RULE 1168, WHICHEVER IS STRICTER.
- 9. NO SMOKING. SMOKING, VAPING, AND SMOKELESS TOBACCO USE IS NOT PERMITTED WITHIN THE BUILDING, OR WITHIN 25'-0" OF ENTRANCES, OPERABLE WINDOWS, OR OUTDOOR AIR INTAKES.
- 10. CAST-IN-PLACE CONCRETE. PROVIDE STEEL REINFORCING MATERIALS WITH MINIMUM 25% RECYCLED CONTENT. PROVIDE AGGREGATE AND CEMENT EXTRACTED AND/OR MANUFACTURED WITHIN 500 MILES OF PROJECT SITE.
- 11. UNIT MASONRY. PROVIDE BRICK, BLOCK, AGGREGATE, CEMENT, MORTAR, AND LIME EXTRACTED AND/OR MANUFACTURED WITHIN 500 MILES OF PROJECT SITE.
- 12. STRUCTURAL STEEL, STEEL DECKING, FORMED METAL FRAMING, METAL TOILET COMPARTMENTS, AND FORMED METAL WALL AND ROOF PANELS. PROVIDE MATERIALS WITH POST-CONSUMER RECYCLED CONTENT PLUS ONE-HALF OF PRECONSUMER RECYCLED CONTENT NOT LESS THAN 25%.
- 13. ALL COMPOSITE WOOD PRODUCTS SHALL BE MANUFACTURED WITHOUT ADDED UREA FORMALDEHYDE.
- 14. ALUMINUM ENTRANCE AND WINDOW SYSTEMS. PROVIDE ALUMINUM MATERIALS WITH POST-CONSUMER RECYCLED CONTENT PLUS ONE-HALF OF PRE-CONSUMER RECYCLED CONTENT NOT LESS THAN 50%.
- 15. PROVIDE GYPSUM BOARD WALL PANELS MANUFACTURED WITHIN 500 MILES OF
- 16. RESILIENT HARD SURFACE FLOORING MATERIALS AND THEIR ADHESIVES SHALL
- 17. PLUMBING FIXTURES SHALL BE WATERSENSE CERTIFIED.

ARCHITECTURAL DRAWINGS


EXTERIOR ELEVATIONS

ROOF PLAN

SHEET NO. SHEET NAME COVER SHEET GENERAL INFORMATION D2.1 LEVEL 1 DEMOLITION PLAN D2.2 ROOF DEMOLITION PLAN A1.1 SITE PLAN A2.1 LEVEL 1 FLOOR PLAN EXTERIOR ELEVATIONS A9.1 SCHEDULES DETAILS

A4.2



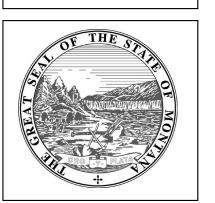

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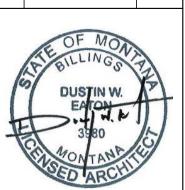
PHONE: 406.994.5413

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MSU PAISLEY COURTON HOUSING

C&E

DRAWN BY: **Author**REVIEWED BY**Checker**REV. DESCRIPTION DATE



PPA #: 21-0143

A/E # 21-0143 A&E PROJ #: 23123.00

SHEET TITLE

GENERAL
INFORMATION

SHEET

GO.T

03/29/24

GENERAL NOTES

. 101 BUILDING 'B/C' & 102 BUILDING 'B/C' ARE MIRRORED VERSIONS OF TYPICAL BUILDING.
GUTTERS AND DOWNSPOUTS TO BE REMOVED AND REPLACED THROUGHOUT

KEYNOTES

REMOVE EXISTING SIDING DOWN TO EXTERIOR SHEATHING, INCLUDING ALL TRIM PIECES, SOFFIT BOARDS, FLASHING, AND ANY EXISTING BUILDING

B PROTECT EXISTING BRICK TO REMAIN.

C REMOVE EXSTING WINDOWS, INCLUDING FLASHING AS REQUIRED FOR INSTALLATION OF NEW WINDOWS.

DEMOLITION LEGEND

HATCH INDICATES AREA NOT IN SCOPE OF WORK

- - - INDICATES BUILT ITEM TO BE REMOVED

O INDICATES LIGHT FIXTURE TO BE REMOVED

DEMOLITION NOTES

- IT IS THE CONTRACTOR'S RESPONSIBILITY TO FAMILIARIZE HIMSELF/ HERSELF WITH THE SCOPE
 OF WORK
- 2. THE DEMOLITION NOTES PROVIDE A GENERAL DESCRIPTION OF THE ITEMS AND AREAS REQUIRING REMOVAL. THE CONTRACTOR SHALL FIELD VERIFY ACTUAL QUANTITIES AND LOCATIONS OF ALL INDICATED ITEMS AS NECESSARY TO COMPLETE THE SCOPE OF WORK IN ACCORDANCE WITH THE CONTRACT DOCUMENTS.
- 3. COORDINATE WITH OWNER FOR ANY EQUIPMENT TO BE SALVAGED. UNLESS SPECIFICALLY SCHEDULED FOR REUSE, DEMOLISHED MATERIALS SHALL BECOME THE POSSESSION OF THE CONTRACTOR AND SHALL BE IMMEDIATELY REMOVED FROM THE SITE.
- 4. REMOVE MATERIALS FROM SITE AND DISPOSE OF IN A LEGAL MANNER AT NO ADDITIONAL EXPENSE TO OWNER
- DEBRIS FROM THE DEMOLITION SHALL NOT BE ALLOWED TO ACCUMULATE WITHIN THE BUILDING OR ON THE SITE.
- REMOVE FROM SITE ANY CONTAMINATED, VERMIN INFESTED, OR DANGEROUS MATERIALS ENCOUNTERED AND DISPOSE OF BY SAFE MEANS SO AS NOT TO ENDANGER HEALTH OF WORKERS AND PUBLIC.
- 7. BURNING OF MATERIALS ON SITE IS NOT PERMITTED.
- 8. CLEAN-UP: MUST MEET GOVERNING DUST CONTROL CO
- 9. NOTIFY AFFECTED UTILITY COMPANIES BEFORE STARTING WORK AND COMPLY WITH THEIR REQUIREMENTS.
- PREVENT MOVEMENT OR SETTLEMENT OF ADJACENT STRUCTURES. PROVIDE BRACING AND SHORING.
- CARRY OUT DEMOLITION WORK TO CAUSE AS LITTLE INCONVENIENCE TO ANY ADJACENT OCCUPIED BUILDING OR SITE AS POSSIBLE AND WITH MINIMUM INTERFERENCE TO PUBLIC OR
- 12. CONTRACTOR SHALL PROVIDE TEMPORARY DUST AND CONSTRUCTION SEPARATION WALLS AS REQUIRED TO SHIELD THE PUBLIC FROM NOISE, DUST, WEATHER, AND OTHER HAZARDS THAT

PRIVATE ACCESSES. MAINTAIN PROTECTED EGRESS AND ACCESS AT ALL TIMES.


- MAY BE EXPOSED AS A RESULT OF THE DEMOLITION WORK.

 13. PERFORM CUTTING OF EXISTING CONCRETE AND MASONRY WITH SAWS AND CORE DRILLS. DO
- 14. BREAK CONCRETE AND MASONRY INTO SECTIONS LESS THAN 3 FEET IN ANY DIMENSION.

NOT USE JACK-HAMMERS EXCEPT WHERE PERMITTED BY OWNER.

- 15. CONTRACTOR SHALL TAKE ALL NECESSARY PRECAUTIONS TO INSURE EXISTING STRUCTURAL ELEMENTS REMAIN UNDAMAGED THROUGHOUT CONSTRUCTION, UNLESS SPECIFICALLY NOTED ON DEMOLITION PLAN. IT IS THE SOLE RESPONSIBILITY OF THE CONTRACTOR TO IDENTIFY AND PROVIDE ANY SHORING, BRACING, OR TEMPORARY STRUCTURE, AND TO COORDINATE WITH STRUCTURAL ENGINEER AS REQUIRED.
- 16. ALL PUBLIC UTILITIES TO REMAIN IN OPERATION THROUGHOUT CONSTRUCTION. CONTRACTOR TO COORDINATE ANY TEMPORARY SERVICES REQUIRED TO MAINTAIN BUSINESS OPERATIONS.
- SEE ENGINEERING DRAWINGS FOR DUCTWORK, DIFFUSER, PLENUM BOX, ETC. DEMOLITION AND/OR PROTECTION. COORDINATE WITH MECHANICAL ENGINEER.
- 18. FIRE SAFETY MUST BE MAINTAINED FOR ALL PERSONNEL WORKING ON THE FLOOR. ALL FIRE STAIRS, ALARMS, SPEAKERS, ETC. MUST REMAIN ACCESSIBLE AND OPERABLE AT ALL TIMES. CONTRACTOR SHALL MAKE NECESSARY PROVISIONS TO PROTECT THIS EQUIPMENT. IMMEDIATELY NOTIFY BUILDING SECURITY AND BUILDING MANAGER OF DAMAGED OR DISABLED SYSTEMS AND REPAIR OR REPLACE DAMAGED SYSTEMS IMMEDIATELY. RELOCATION OF SMOKE DETECTORS, PUBLIC ADDRESS SPEAKERS AND FIRE ALARM EQUIPMENT, NECESSITATED BY NEW CONSTRUCTION, SHALL BE ACCOMPLISHED AS A FIRST PRIORITY, AND PER THE PLANS.
- 19. IF ANY QUESTIONS ARISE AS TO THE REMOVAL OF ANY MATERIAL, CLARIFY THE POINT IN QUESTION WITH THE OWNER BEFORE PROCEEDING. IMMEDIATELY STOP WORK IF HAZARDOUS MATERIALS ARE FOUND AND CONTACT THE OWNER'S REPRESENTATIVE.
- 20. REMOVAL OF ANY EQUIPMENT, CABLING SWITCHES, AND CONDUIT PERTAINING TO DATA/COMMUNICATIONS AND TELEPHONE SHALL BE VERIFIED WITH TELEPHONE COMPANIES, SERVICE OWNER OR TENANT DATA/COMMUNICATIONS REPRESENTATIVE AS REQUIRED TO PREVENT NEW CONSTRUCTION DELAYS.
- 21. PROVIDE FOR FIRE PROOFING REPAIR AS REQUIRED AT STRUCTURAL STEEL, TO THE ORIGINAL RATING WHERE CONSTRUCTION TRADES REMOVE EXISTING FIRE PROOFING. REPAIR ANY DAMAGE OR PENETRATIONS IN RATED ASSEMBLIES TO CONFORM TO THEIR ORIGINAL LISTING REQUIREMENTS AND TO MAINTAIN FIRE PROTECTION AND SEPARATION AS ORIGINALLY DESIGNED.
- 22. AT COMPLETION OF DEMOLITION WORK, THE CONSTRUCTION AREA(S) SHALL BE LEFT IN "BROOM CLEAN" CONDITION. ALL DEBRIS AND MISCELLANEOUS MATERIAL SHALL BE REMOVED.
- CONTRACTOR SHALL BE RESPONSIBLE FOR PATCHING AND/OR REPAIRING ANY DAMAGE CAUSED BY HIM OR HIS SUBCONTRACTORS. REFINISH TO MATCH EXISTING ADJACENT FINISH, OR AS NOTED HEREIN.
- FOR AREAS NOT IN DEMOLITION SCOPE OF WORK, PROTECT AS REQUIRED, ALL SURFACES, EQUIPMENT, FIXTURES AND HARDWARE DURING DEMOLITION AND/OR CONSTRUCTION.
- PRIOR TO DEMOLITION, INVESTIGATE WALLS FOR CONCEALED PIPING AND INFORM OWNER/ARCHITECT OF ANY CONDITION NOT DOCUMENTED IN CONTRACT DRAWINGS. DEMO DESIGNATED WALL BASES, WALL FRAMING, BATT INSULATION AND GYPSUM BOARD. DEMO CONDUITS AND RECEPTACLES, REFERENCE ELECTRICAL DEMO PLAN FOR ADDITIONAL
- 3. ALL EXISTING DIRECTIONAL SIGNAGE TO BE REMOVED UNLESS NOTED OTHERWISE.
- WHERE NOTED, REMOVE FLOORING DOWN TO TOP OF CONC. SLAB, INCLUDING ADHESIVES, TRANSITION STRIPS, AND OTHER ASSOCIATED ELEMENTS, TYP., UNLESS NOTED OTHERWISE. PREPARE REMAINING SURFACES TO RECEIVE NEW FINISHES.



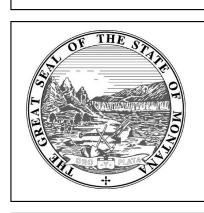


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PAISLEY COURT HOUSING

MSU



DRAWN BY: **Author**REVIEWED BY**Checker**REV. DESCRIPTION DATE

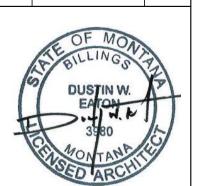

A #: 21-0143

A#: 21-0

A/E # 21-0143 A&E PROJ #: 23123.00

SHEET TITLE
LEVEL 1

SPLANT

UZ.T

GENERAL NOTES

101 BUILDING 'B/C' & 102 BUILDING 'B/C' ARE MIRRORED VERSIONS OF TYPICAL BUILDING. GUTTERS AND DOWNSPOUTS TO BE REMOVED AND REPLACED THROUGHOUT

KEYNOTES

D ALTERNATE #1: REMOVE AND LEGALLY DISPOSE OF 3'-0" OF SHINGLES AT ALL ROOF EDGES FOR INSTALLATION OF NEW DRIP EDGE FLASHING.

E REMOVE AND LEGALLY DISPOSE OF ALL GUTTERS AND FASTENERS

DEMOLITION LEGEND

HATCH INDICATES AREA NOT IN SCOPE OF WORK

- - - INDICATES BUILT ITEM TO BE REMOVED

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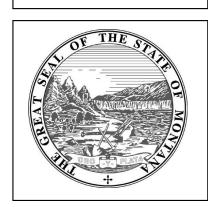
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- REMOVE MATERIALS FROM SITE AND DISPOSE OF IN A LEGAL MANNER AT NO ADDITIONAL
- DEBRIS FROM THE DEMOLITION SHALL NOT BE ALLOWED TO ACCUMULATE WITHIN THE BUILDING
- REMOVE FROM SITE ANY CONTAMINATED, VERMIN INFESTED, OR DANGEROUS MATERIALS ENCOUNTERED AND DISPOSE OF BY SAFE MEANS SO AS NOT TO ENDANGER HEALTH OF WORKERS AND PUBLIC.
- BURNING OF MATERIALS ON SITE IS NOT PERMITTED.
- CLEAN-UP: MUST MEET GOVERNING DUST CONTROL CODES.
- NOTIFY AFFECTED UTILITY COMPANIES BEFORE STARTING WORK AND COMPLY WITH THEIR
- PREVENT MOVEMENT OR SETTLEMENT OF ADJACENT STRUCTURES. PROVIDE BRACING AND
- CARRY OUT DEMOLITION WORK TO CAUSE AS LITTLE INCONVENIENCE TO ANY ADJACENT
- OCCUPIED BUILDING OR SITE AS POSSIBLE AND WITH MINIMUM INTERFERENCE TO PUBLIC OR PRIVATE ACCESSES. MAINTAIN PROTECTED EGRESS AND ACCESS AT ALL TIMES.
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- PERFORM CUTTING OF EXISTING CONCRETE AND MASONRY WITH SAWS AND CORE DRILLS. DO NOT USE JACK-HAMMERS EXCEPT WHERE PERMITTED BY OWNER.
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- IF ANY QUESTIONS ARISE AS TO THE REMOVAL OF ANY MATERIAL, CLARIFY THE POINT IN QUESTION WITH THE OWNER BEFORE PROCEEDING. IMMEDIATELY STOP WORK IF HAZARDOUS MATERIALS ARE FOUND AND CONTACT THE OWNER'S REPRESENTATIVE.
- REMOVAL OF ANY EQUIPMENT, CABLING SWITCHES, AND CONDUIT PERTAINING TO DATA/COMMUNICATIONS AND TELEPHONE SHALL BE VERIFIED WITH TELEPHONE COMPANIES, SERVICE OWNER OR TENANT DATA/COMMUNICATIONS REPRESENTATIVE AS REQUIRED TO PREVENT NEW CONSTRUCTION DELAYS.
- PROVIDE FOR FIRE PROOFING REPAIR AS REQUIRED AT STRUCTURAL STEEL, TO THE ORIGINAL RATING WHERE CONSTRUCTION TRADES REMOVE EXISTING FIRE PROOFING. REPAIR ANY DAMAGE OR PENETRATIONS IN RATED ASSEMBLIES TO CONFORM TO THEIR ORIGINAL LISTING REQUIREMENTS AND TO MAINTAIN FIRE PROTECTION AND SEPARATION AS ORIGINALLY DESIGNED.
- AT COMPLETION OF DEMOLITION WORK, THE CONSTRUCTION AREA(S) SHALL BE LEFT IN "BROOM CLEAN" CONDITION. ALL DEBRIS AND MISCELLANEOUS MATERIAL SHALL BE REMOVED.
- CONTRACTOR SHALL BE RESPONSIBLE FOR PATCHING AND/OR REPAIRING ANY DAMAGE CAUSED BY HIM OR HIS SUBCONTRACTORS. REFINISH TO MATCH EXISTING ADJACENT FINISH,
- FOR AREAS NOT IN DEMOLITION SCOPE OF WORK, PROTECT AS REQUIRED, ALL SURFACES, EQUIPMENT, FIXTURES AND HARDWARE DURING DEMOLITION AND/OR CONSTRUCTION.
- PRIOR TO DEMOLITION, INVESTIGATE WALLS FOR CONCEALED PIPING AND INFORM OWNER/ARCHITECT OF ANY CONDITION NOT DOCUMENTED IN CONTRACT DRAWINGS. DEMO DESIGNATED WALL BASES, WALL FRAMING, BATT INSULATION AND GYPSUM BOARD. DEMO CONDUITS AND RECEPTACLES, REFERENCE ELECTRICAL DEMO PLAN FOR ADDITIONAL
- ALL EXISTING DIRECTIONAL SIGNAGE TO BE REMOVED UNLESS NOTED OTHERWISE.

INFORMATION.

WHERE NOTED. REMOVE FLOORING DOWN TO TOP OF CONC. SLAB. INCLUDING ADHESIVES. TRANSITION STRIPS, AND OTHER ASSOCIATED ELEMENTS, TYP., UNLESS NOTED OTHERWISE. PREPARE REMAINING SURFACES TO RECEIVE NEW FINISHES.






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PAISLEY HOUSIN MSU



DRAWN BY: Author REVIEWED BY**Checker** REV. DESCRIPTION DATE



PPA #: 21-0143

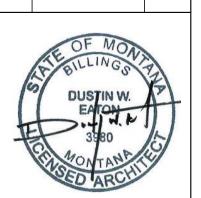A/E #

21-0143 A&E PROJ #: 23123.00

SHEET TITLE **DEMOLITION**

✓ SITE PLAN (TYP) 1/16" = 1'-0"

NOTE: 101 BUILDING 'B/C' & 102 BUILDING 'B/C' ARE MIRRORED VERSIONS OF TYPICAL BUILDING.



108 (BUILDING C) 109 (BUILDING C) 103 (BUILDING C) (BUILDING C) 104 (BUILDING A) (BUILDING A) 108 (BUILDING A 103 (BUILDING A 107 (BUILDING B) 105 (BUILDING B) 102 (BUILDING A) (BUILDING A) (BUILDING A) (BUILDING A) (BUILDING A) 105 (BUILDING C) 106 (BUILDING C) 102 (BUILDING C) (BUILDING C) (BUILDING C) - SITE PLAN (TYP) REF: A1.1 / 1

GENERAL NOTES

1. 101 BUILDING 'B/C' & 102 BUILDING 'B/C' ARE MIRRORED VERSIONS OF TYPICAL BUILDING.

SITE PLAN LEGEND


GUTTER LOCATIONS

DOWNSPOUT LOCATION

SITE PLAN NOTES

- REFER TO ALL DRAWINGS FOR ADDITIONAL INFORMATION. NOTIFY ARCHITECT OF ANY CONFLICT PRIOR TO COMMENCING WORK.
- REFERENCE LANDSCAPE DRAWINGS FOR ADDITIONAL INFORMATION REGARDING SITE WORK.
- REFERENCE LANDSCAPE DRAWINGS FOR LANDSCAPE REQUIREMENTS, LANDSCAPE AREAS, AND ADDITIONAL INFORMATION.



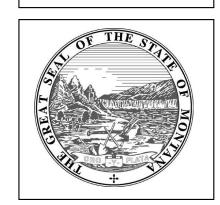


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SHEET TITLE **SITE PLAN**

SHEET

ARE MIRRORED VERSIONS OF TYPICAL BUILDING.

GENERAL NOTES

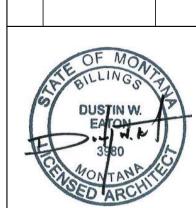1. 101 BUILDING 'B/C' & 102 BUILDING 'B/C' ARE MIRRORED VERSIONS OF TYPICAL BUILDING.

KEYNOTES

FLOOR PLAN NOTES

1. THE CONTRACTOR SHALL NOT CONSIDER CONSTRUCTION NOTES TO BE ALL-INCLUSIVE. IT IS THE CONTRACTOR'S RESPONSIBILITY TO INSPECT AND ASSESS EACH AREA AND TO FULFILL THE INTENT OF THE CONTRACT DOCUMENTS. CONTRACTOR SHALL COORDINATE ARCHITECTURAL CONSTRUCTION DRAWINGS AND NOTES WITH CIVIL, STRUCTURAL, MECHANICAL, ELECTRICAL, & PLUMBING NOTES AND DRAWINGS AND PROJECT MANNUAL.


2. FIELD VERIFY ALL DIMENSIONS. DO NOT SCALE DRAWINGS.

3. ALL FINISHES AND MATERIALS SHALL BE PROPERLY INTEGRATED TO ENSURE A UNIFORM APPERANCE AND SEAMLESS TRANSITION.

4. ALL DIMENSIONS ARE FROM STRUCTURAL OR UNFINISHED FACE OF STUD, UNLESS OTHERWISE NOTED.

5. PATCH AND REPAIR ANY / ALL WALL SURFACES AS REQUIRED TO PROVIDE SUITABLE SUBSTRATE FOR FINISHES.



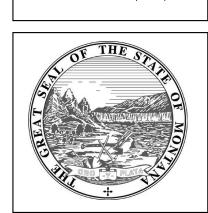

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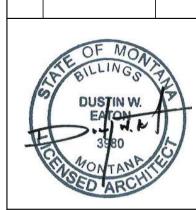
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PPA #: 21-0143

A/E # 21-0143

A&E PROJ #: 23123.00

SHEET TITLE
LEVEL 1 FLOOR
PLAN

SHEET 1


KEYNOTES

1 ALTERNATE #1: PROVIDE NEW UNDERLAYMENT LAPPED OVER EXISTING AND NEW SHINGLES TO MATCH EXISTING.

2 PROVIDE AND INSTALL NEW GUTTER.

3 PROVIDE AND INSTALL NEW DOWNSPOUT AT THIS LOCATION.



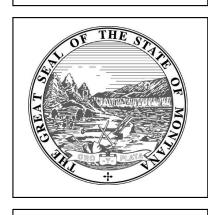


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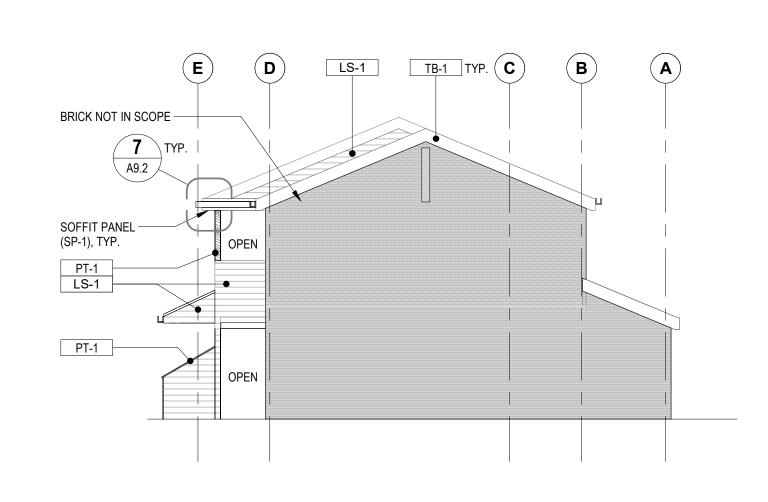
A/E#

21-0143 A&E PROJ #: 23123.00

SHEET TITLE **ROOF PLAN**


SHEET

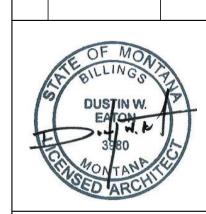A2.2



2 BUILDING A - ELEVATION WEST (TYP)

NOTE: FIELD VERIFY ALL DIMENSIONS.
DO NOT SCALE DRAWINGS.
NOTE: REFERENCE A1.1-1 FOR GUTTER LOCATIONS

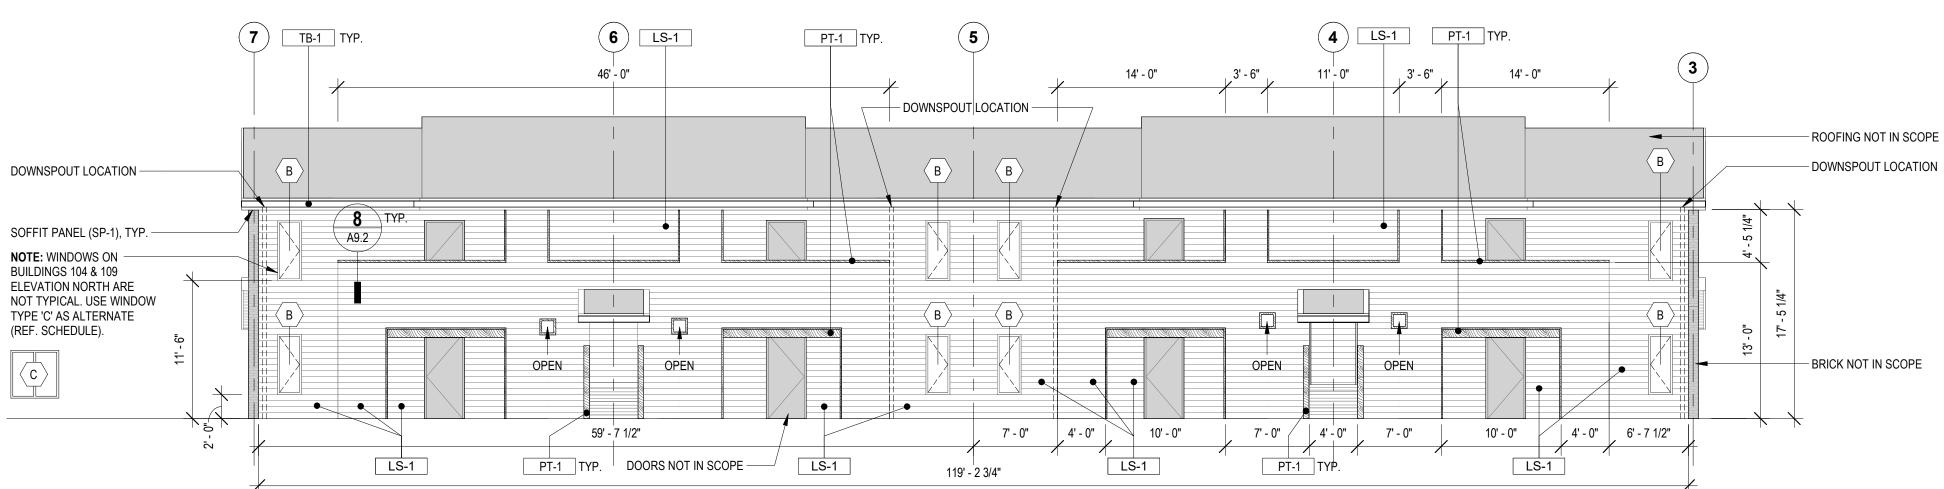

5 BUILDING A - ELEVATION NORTH (TYP)

1/8" = 1'-0"

NOTE: FIELD VERIFY ALL DIMENSIONS.
DO NOT SCALE DRAWINGS.
NOTE: REFERENCE A1.1-1 FOR GUTTER LOCATIONS

TB-1 TYP. DOWNSPOUT LOCATION - DOWNSPOUT LOCATION - ROOFING NOT IN SCOPE ROOF 117' - 5 1/4" - SOFFIT PANEL (SP-1), TYP. SOFFIT PANEL (SP-1), TYP. - BRICK NOT IN SCOPE 4' - 4 3/4" 10' - 3 1/2" | 4' - 6" | 7' - 3 1/4" | 4' - 0" | 60' - 5 1/2" 25' - 3 1/4" — DOORS NOT IN SCOPE LS-1 LS-1 LS-1 - Underside, VS-1, Typ.

 $13\frac{\text{BUILDING A - ELEVATION SOUTH (TYP)}}{1/8" = 1'-0"}$


NOTE: FIELD VERIFY ALL DIMENSIONS.
DO NOT SCALE DRAWINGS.
NOTE: REFERENCE A1.1-1 FOR GUTTER LOCATIONS


MATERIAL LEGEND

LS-

HARDIE PLANK LAP SIDING TEXTURE: SELECT CEDARMILL COLOR: WEATHERED CLIFFS

WIDTH: 7.25"

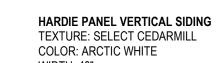

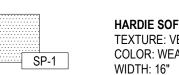


WIDTH: 48"

HARDIE SOFFIT PANEL

TEXTURE: VENTED SMOOTH

COLOR: WEATHERED CLIFFS

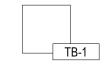

HARDIE TRIM BOARD TEXTURE: 5/4 RUSTIC COLOR: COBBLE STONE WIDTH: 11.25"



SHERWIN-WILLIAMS
TEXTURE: DURATION EXTERIOR
COLOR: SW 9695 (BEETROOT)

GENERAL NOTES


1. WINDOWS ON BUILDINGS 104 & 109 ELEVATION NORTH ARE NOT TYPICAL. USE WINDOW TYPE 'C' AS ALTERNATE (REF. SCHEDULE).

ELEVATION NOTES

FLOOR ELEVATIONS.

DO NOT SCALE DRAWINGS.

- REFER TO STRUCTURAL, MECHANICAL, AND ELECTRICAL DRAWINGS FOR ADDITIONAL INFORMATION. ALL INFORMATION REGARDING EXISTING CONDITIONS IS BASED UPON OWNER-SUPPLIED DOCUMENTS AND MAY NOT PRECISELY REFLECT FIELD CONDITIONS.
- 2. THE CONTRACTOR SHALL NOT CONSIDER CONSTRUCTION NOTES TO BE ALL-INCLUSIVE. IT IS THE CONTRACTOR'S RESPONSIBILITY TO INSPECT AND ASSESS EACH AREA AND TO FULFILL THE INTENT OF THE CONTRACT DOCUMENTS. CONTRACTOR SHALL COORDINATE ARCHITECTURAL CONSTRUCTION DRAWING AND NOTES WITH CIVIL, STRUCTURAL AND MECHANICAL, ELECTRICAL & PLUMBING NOTES AND DRAWINGS.
- . FIELD VERIFY ALL DIMENSIONS. DO NOT SCALE DRAWINGS.
- 4. ALL FINISHES AND MATERIALS SHALL BE PROPERLY INTEGRATED TO ENSURE A UNIFORM APPEARANCE AND SEAMLESS TRANSITION.
- PROVIDE ALL BACKING FOR MILLWORK, GRAB BARS, AND ANY AND ALL WALL MOUNTED EQUIPMENT O ACCESSORIES; COORDINATE LOCATIONS.
- ALL DIMENSIONS ARE FROM STRUCTURAL OR UNFINISHED FACE OF STUD, UNLESS OTHERWISE NOTED.
 GENERAL CONTRACTOR SHALL COORDINATE ALL ASPECTS OF THE BUILDING CONSTRUCTION.
- PROVIDE A SMOOTH AND LEVEL FINISH FLOOR, TYP. PATCH AND REPAIR ALL INCONSISTENCIES IN
- 9. PATCH AND REPAIR ANY / ALL WALL SURFACES AS REQUIRED TO PROVIDE SUITABLE SUBSTRATE FOR
- FINISHES.
- O. U.L. ASSEMBLIES DESCRIBED ARE FOR REFERENCE ONLY. THE GENERAL CONTRACTOR SHALL COORDINATE AND VERIFY THE INSTALLATION OF THE DESCRIBED SYSTEM(S).
- 11. REFER TO DOOR AND FRAME SCHEDULE FOR DOORS REQUIRING ADA ACCESS CONTROL.
- 12. LOCATE THE HINGE SIDE JAMB OF DOORS 4" FROM ADJACENT PERPENDICULAR WALL, UNLESS NOTED OTHERWISE.
- 13. PROVIDE ACOUSTICAL SEALANT AROUND WALL EDGES, TOP AND BOTTOM, AND PENETRATIONS, AND INSTALL PUTTY PADS AROUND ELECTRICAL BOXES WHERE PARTITION CONTAINS ACOUSTICAL INSULATION.
 - REFER TO SPECIFICATIONS FOR CODE REQUIRED SIGNAGE. PROVIDE ADDITIONAL SIGNAGE AS MAY BE REQUIRED BY REQUEST OF THE FIRE MARSHAL AND/OR BUILDING CODE OFFICIAL.

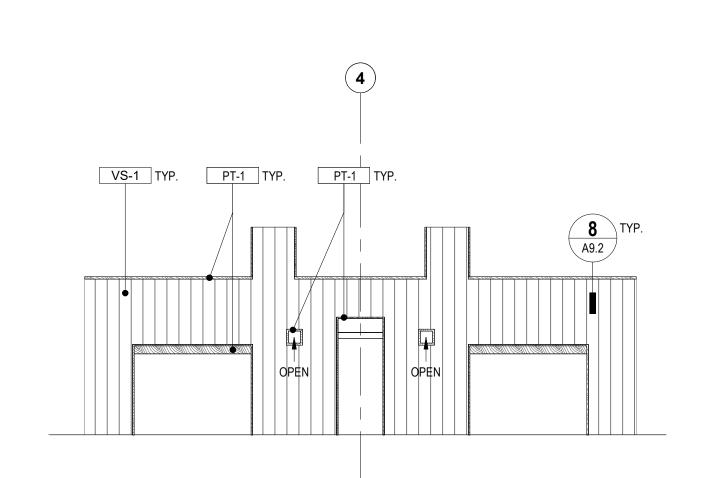


15 BUILDING A - ELEVATION BACKSIDE ENTRY WALL (TYP)

1/8" = 1'-0"

NOTE: FIELD VERIFY ALL DIMENSIONS.



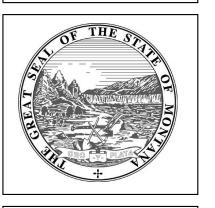

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PPA #: 21-0143

A/E # 21-0143 A&E PROJ #: 23123.00

SHEET TITLE

EXTERIOR

ELEVATIONS

SHEET

A4.1

03/29/24

■ BUILDING B - ELEVATION WEST (TYP)

LS-1 DOORS NOT IN SCOPE

8' - 2 1/4"

TB-1 TYP.

LS-1

NOTE: FIELD VERIFY ALL DIMENSIONS. DO NOT SCALE DRAWINGS. **NOTE:** 101 BUILDING 'B' & 102 BUILDING 'B' ARE MIRRORED VERSIONS OF TYPICAL BUILDING.

LS-1

14' - 9 3/4"

- ROOFING NOT IN SCOPE

SOFFIT PANEL (SP-1), TYP.

- BRICK NOT IN SCOPE

BUILDING C ROOF CONNECTION

- SOFFIT PANEL

(SF-1), TYP.


PT-1

TB-1 TYP. LS-1 PT-1 TYP. - BRICK NOT IN SCOPE 11' - 7 3/4" 15' - 0" - SOFFIT PANEL (SP-1), TYP. LS-1 - DOWNSPOUT LOCATION

BUILDING B - ELEVATION NORTH (TYP)

NOTE: FIELD VERIFY ALL DIMENSIONS. DO NOT SCALE DRAWINGS. NOTE: 101 BUILDING 'B' & 102 BUILDING 'B' ARE MIRRORED VERSIONS OF TYPICAL BUILDING. NOTE: REFERENCE A1.1-1 FOR GUTTER LOCATIONS


GENERAL NOTES

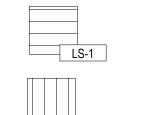

HARDIE PLANK LAP SIDING TEXTURE: SELECT CEDARMILL COLOR: WEATHERED CLIFFS WIDTH: 7.25"




HARDIE PANEL VERTICAL SIDING TEXTURE: SELECT CEDARMILL COLOR: ARCTIC WHITE WIDTH: 48"

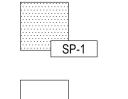

TEXTURE: VENTED SMOOTH COLOR: WEATHERED CLIFFS WIDTH: 16"

> HARDIE TRIM BOARD TEXTURE: 5/4 RUSTIC


COLOR: COBBLE STONE

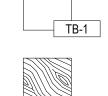

WIDTH: 11.25" SHERWIN-WILLIAMS TEXTURE: DURATION EXTERIOR COLOR: SW 9695 (BEETROOT)

GENERAL NOTES

101 BUILDING 'B/C' & 102 BUILDING 'B/C' ARE MIRRORED VERSIONS OF TYPICAL BUILDING.

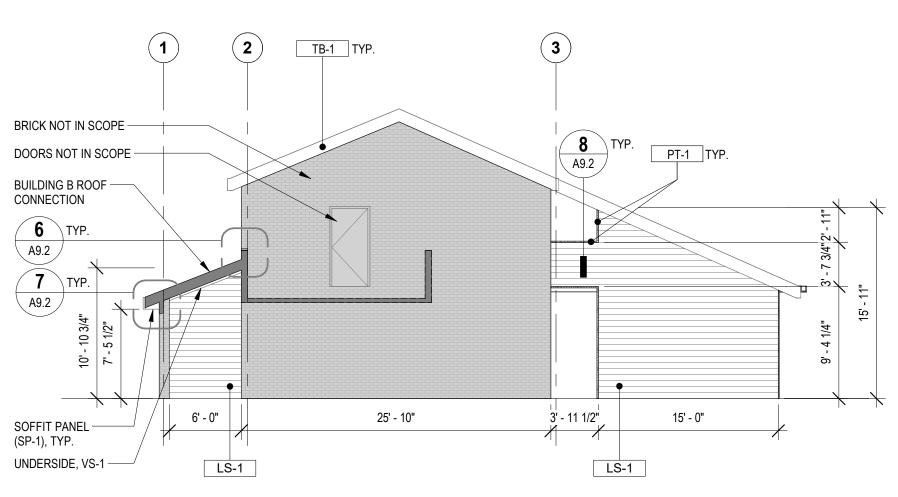

OF TYPICAL BUILDING.


■ BUILDING B - ELEVATION SOUTH (TYP)

1/8" = 1'-0"

NOTE: FIELD VERIFY ALL DIMENSIONS. DO NOT SCALE DRAWINGS. NOTE: 101 BUILDING 'B' & 102 BUILDING 'B' ARE MIRRORED VERSIONS OF TYPICAL BUILDING. **NOTE:** REFERENCE A1.1-1 FOR GUTTER LOCATIONS


NOTE: FIELD VERIFY ALL DIMENSIONS. DO NOT SCALE DRAWINGS.

NOTE: 101 BUILDING 'B' & 102 BUILDING 'B' ARE MIRRORED VERSIONS

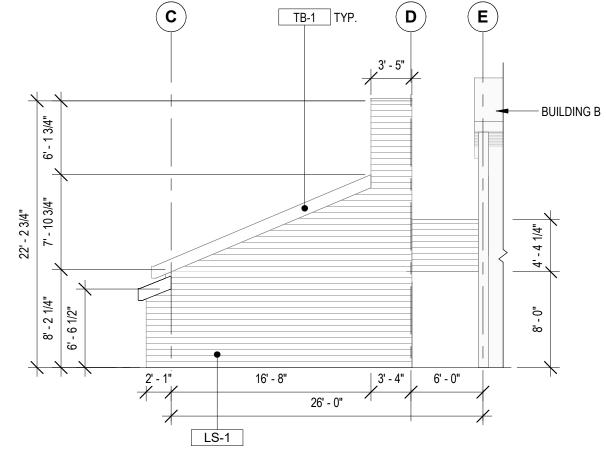

■ BUILDING C - ELEVATION EAST (TYP)

NOTE: FIELD VERIFY ALL DIMENSIONS. DO NOT SCALE DRAWINGS. NOTE: 101 BUILDING 'C' & 102 BUILDING 'C' ARE MIRRORED VERSIONS OF TYPICAL BUILDING.

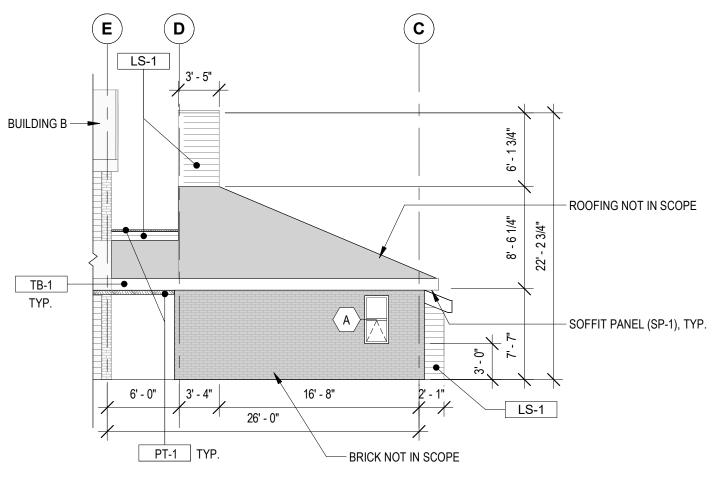


→ BUILDING C - ELEVATION WEST (TYP)

1/8" = 1'-0"

NOTE: FIELD VERIFY ALL DIMENSIONS. DO NOT SCALE DRAWINGS. NOTE: 101 BUILDING 'C' & 102 BUILDING 'C' ARE MIRRORED VERSIONS OF TYPICAL BUILDING.


ELEVATION NOTES

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- ALL DIMENSIONS ARE FROM STRUCTURAL OR UNFINISHED FACE OF STUD, UNLESS OTHERWISE NOTED.
- GENERAL CONTRACTOR SHALL COORDINATE ALL ASPECTS OF THE BUILDING CONSTRUCTION.
- PROVIDE A SMOOTH AND LEVEL FINISH FLOOR, TYP. PATCH AND REPAIR ALL INCONSISTENCIES IN FLOOR ELEVATIONS.
- PATCH AND REPAIR ANY / ALL WALL SURFACES AS REQUIRED TO PROVIDE SUITABLE SUBSTRATE FOR
- U.L. ASSEMBLIES DESCRIBED ARE FOR REFERENCE ONLY. THE GENERAL CONTRACTOR SHALL COORDINATE AND VERIFY THE INSTALLATION OF THE DESCRIBED SYSTEM(S)
- REFER TO DOOR AND FRAME SCHEDULE FOR DOORS REQUIRING ADA ACCESS CONTROL.
- LOCATE THE HINGE SIDE JAMB OF DOORS 4" FROM ADJACENT PERPENDICULAR WALL, UNLESS NOTED
- PROVIDE ACOUSTICAL SEALANT AROUND WALL EDGES, TOP AND BOTTOM, AND PENETRATIONS, AND INSTALL PUTTY PADS AROUND ELECTRICAL BOXES WHERE PARTITION CONTAINS ACOUSTICAL
- REFER TO SPECIFICATIONS FOR CODE REQUIRED SIGNAGE. PROVIDE ADDITIONAL SIGNAGE AS MAY BE REQUIRED BY REQUEST OF THE FIRE MARSHAL AND/OR BUILDING CODE OFFICIAL.

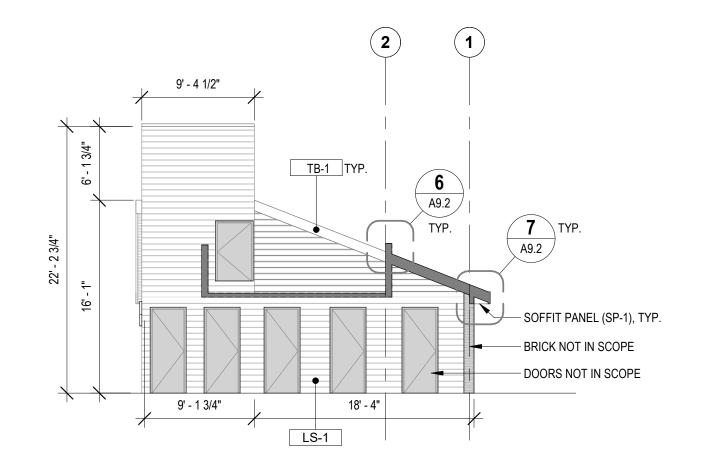


 $13\frac{\text{BUILDING C - ELEVATION NORTH (TYP)}}{1/8" = 1'-0"}$

NOTE: FIELD VERIFY ALL DIMENSIONS. DO NOT SCALE DRAWINGS. NOTE: 101 BUILDING 'C' & 102 BUILDING 'C' ARE MIRRORED VERSIONS OF TYPICAL BUILDING.

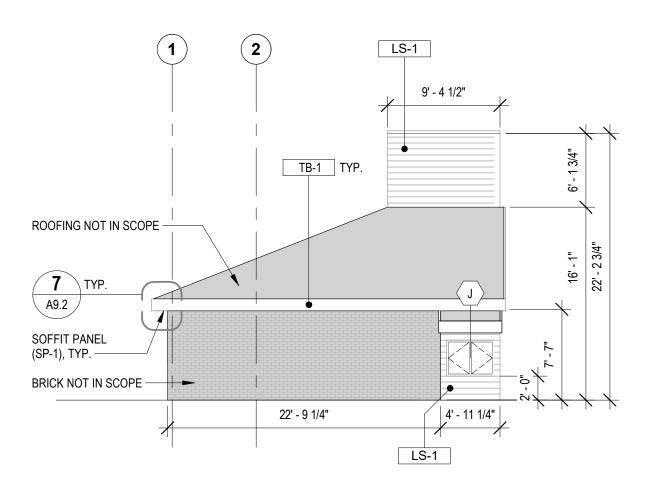

 $14 \frac{\text{BUILDING C - ELEVATION SOUTH (TYP)}}{1/8" = 1'-0"}$

NOTE: FIELD VERIFY ALL DIMENSIONS. DO NOT SCALE DRAWINGS. **NOTE:** 101 BUILDING 'C' & 102 BUILDING 'C' ARE MIRRORED VERSIONS OF TYPICAL BUILDING.

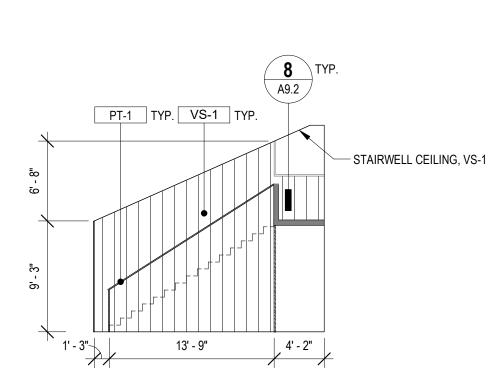

15 BUILDING B - ELEVATION STAIRWELL INTERIOR (TYP)

1/8" = 1'-0"

NOTE: FIELD VERIFY ALL DIMENSIONS. DO NOT SCALE DRAWINGS. NOTE: 101 BUILDING 'B' & 102 BUILDING 'B' ARE MIRRORED VERSIONS OF TYPICAL BUILDING.

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PPA #: 21-0143

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SHEET TITLE **EXTERIOR ELEVATIONS**


SHEET

03/29/24

WINDOW SCHEDULE											
WINDOW HEAD GI											
NUMBER	WIDTH	HEIGHT	SILL HEIGHT	HEIGHT	TYPE						
	•										
A	2' - 0"	4' - 0"	<varies></varies>	<varies></varies>	GL-1						
В	2' - 0"	5' - 0"	<varies></varies>	<varies></varies>	GL-1						
С	4' - 0"	4' - 0"	<varies></varies>	<varies></varies>	GL-1						
D	2' - 0"	2' - 0"	<varies></varies>	<varies></varies>	GL-1						
E	5' - 8"	4' - 0"	3' - 0"	7' - 0"	GL-1						
F	5' - 8"	5' - 0"	2' - 0"	7' - 0"	GL-1						
G	8' - 0"	5' - 0"	<varies></varies>	<varies></varies>	GL-1						
Н	8' - 0"	4' - 0"	3' - 0"	7' - 0"	GL-1						
I	2' - 0"	3' - 0"	2' - 0"	5' - 0"	GL-1						
J	4' - 0"	3' - 0"	2' - 0"	5' - 0"	GL-1						
	1	•	1								

WINDOW TYPE ELEVATIONS - VIF


NOTE: FIELD VERIFY ALL DIMENSIONS. DO NOT SCALE DRAWINGS.

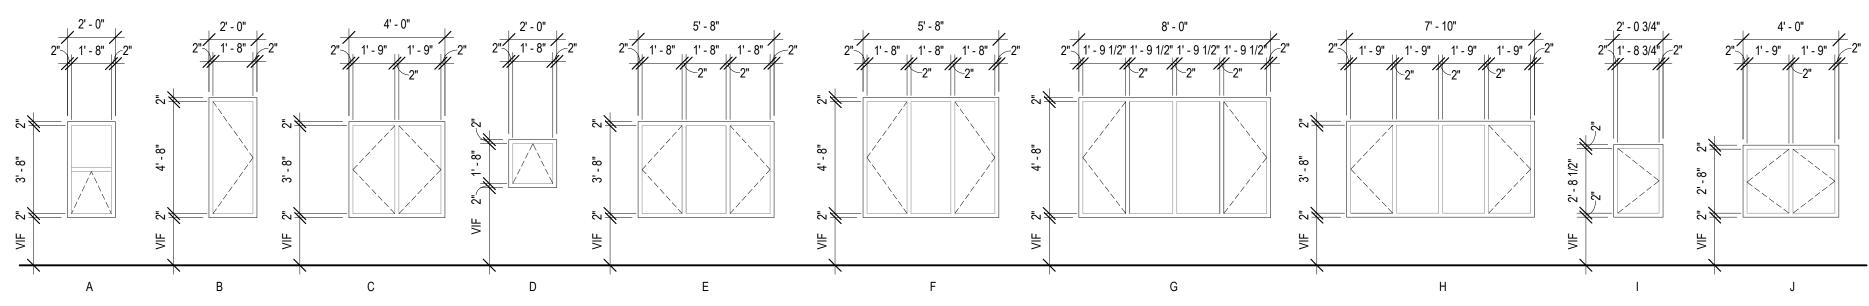

GLAZING NOTES

GLAZING TO BE GL-1 UNLESS OTHERWISE SPECIFIED.
 REFERENCE EXTERIOR ELEVATION FOR OPERABLE WINDOW OPENING DIRECTIONS.



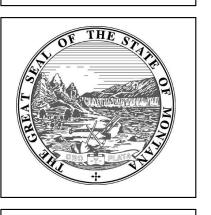


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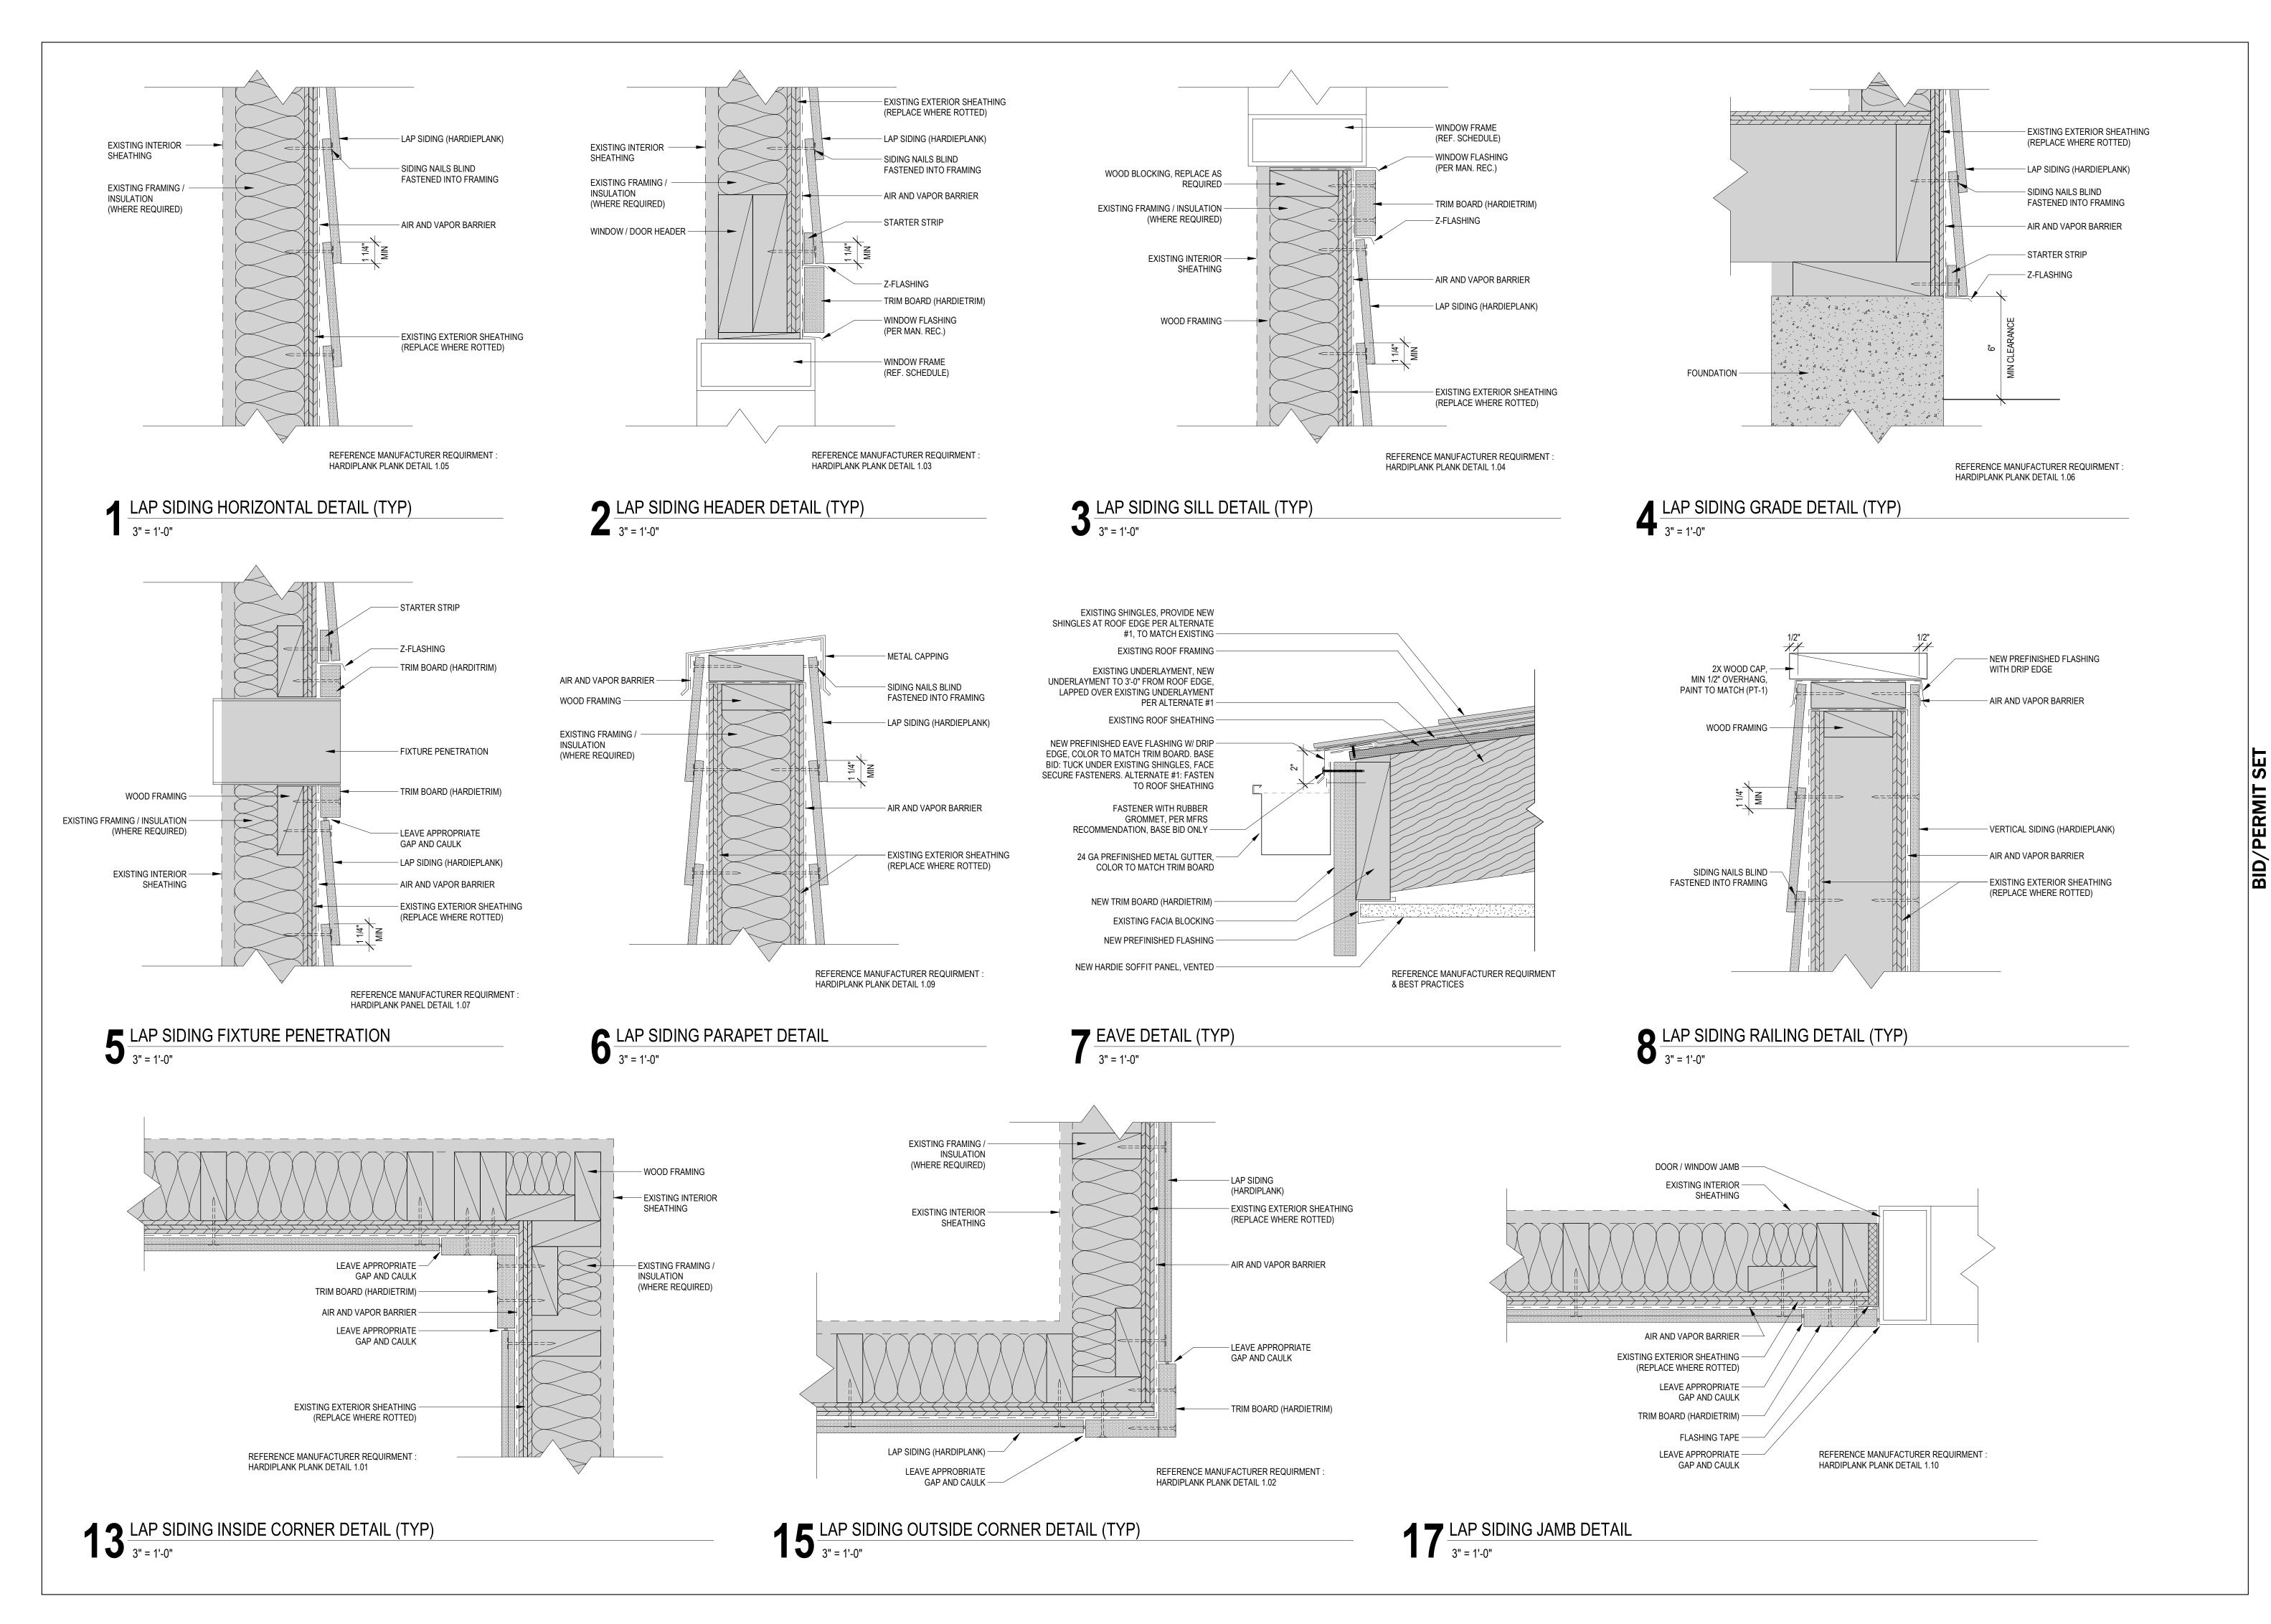


21-0143 A/E#


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SHEET TITLE **SCHEDULES**

SHEET

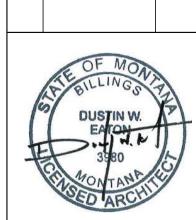



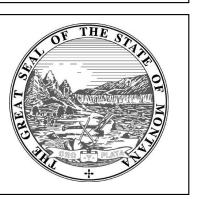

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DUSTIN W.
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PPA #: 21-0143

A/E # 21-0143

A&E PROJ #: 23123.00

SHEET TITLE

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A9.2